


NOTES

1. THIS UNIT IS BASED ON OUR STANDARD PRODUCT SPECIFICATION
2. DRAWING SHOULD BE READ IN CONJUNCTION WITH CURRENT VERSION OF THE DRAWING LEGEND.
3. JACK LEG BRACKETS CANNOT BE FITTED DUE TO SIZE OF UNIT.
4. STAIRCASE BRACKET NOT FITTED
5. CLIENT FLEET REFERENCE NUMBER TO BE ENTERED ONTO IDENTITY PLATE: P2791


USE DIMENSIONS - DO NOT SCALE		
Dimension Units ALL IN MILLIMETRES		
COLOUR	GREY (RAL 7045)	
FOUNDATION	015692-F1	
UNLADEN WEIGHT (KG)	1400	
MAXIMUM LADEN WEIGHT (KG)	2400	
MAXIMUM LIFT WEIGHT (KG)	2400	
Title 6' X 6' FLAT STEEL GATEHOUSE UNIT		
Product Code		
Date 04/11/19	Scale 1 : 30	Drawn By RMC
Drawing / Unit No. 45376		Rev. -

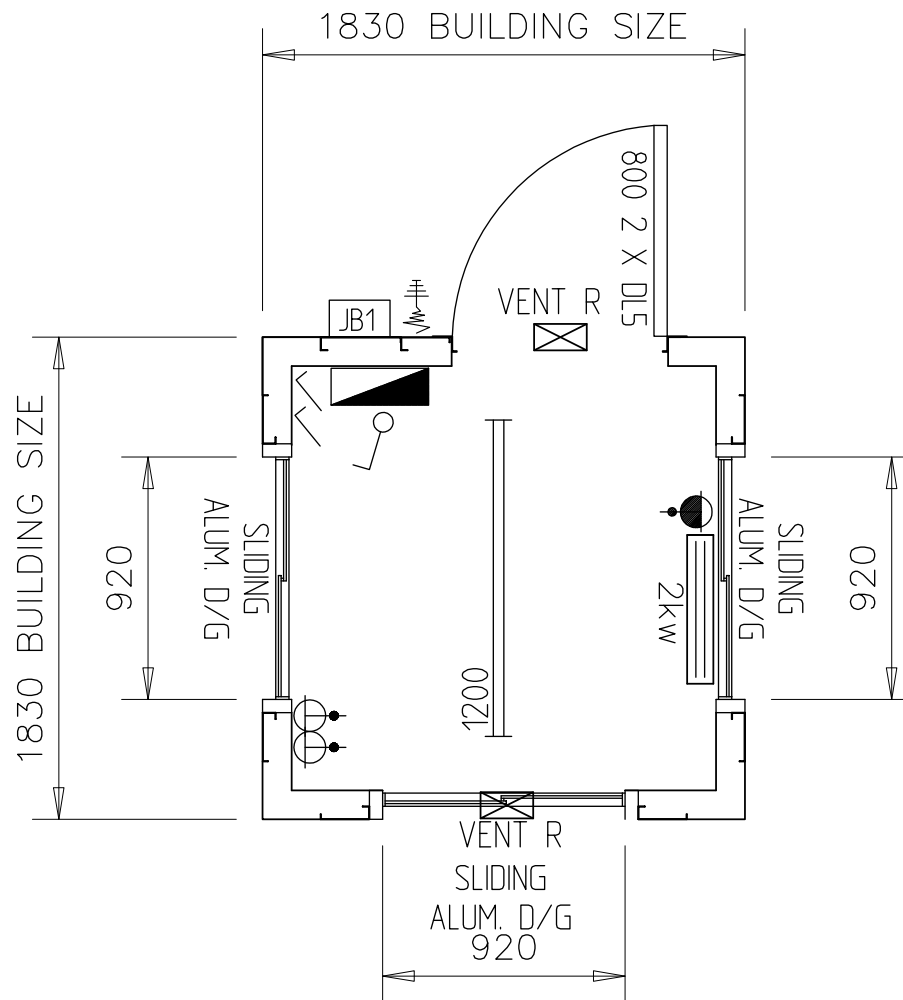


NOTES

1. THIS UNIT IS BASED ON OUR STANDARD PRODUCT SPECIFICATION
2. DRAWING SHOULD BE READ IN CONJUNCTION WITH CURRENT VERSION OF THE DRAWING LEGEND.
3. JACK LEG BRACKETS CANNOT BE FITTED DUE TO SIZE OF UNIT.
4. STAIRCASE BRACKET NOT FITTED
5. CLIENT FLEET REFERENCE NUMBER TO BE ENTERED ONTO IDENTITY PLATE: P2792

USE DIMENSIONS - DO NOT SCALE		
Dimension Units ALL IN MILLIMETRES		
COLOUR	GREY (RAL 7045)	
FOUNDATION	015692-F1	
UNLADEN WEIGHT (KG)	1400	
MAXIMUM LADEN WEIGHT (KG)	2400	
MAXIMUM LIFT WEIGHT (KG)	2400	
Title 6' X 6' FLAT STEEL GATEHOUSE UNIT		
Product Code		
Date 04/11/19	Scale 1 : 30	Drawn By RMC
Drawing / Unit No. 45377		Rev. -

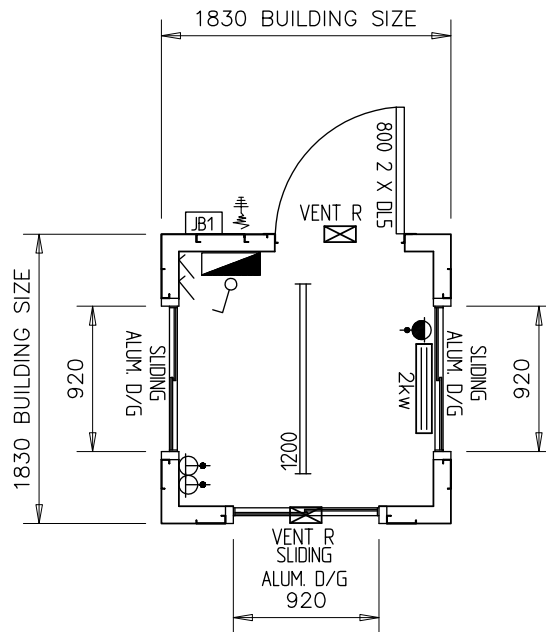

45376



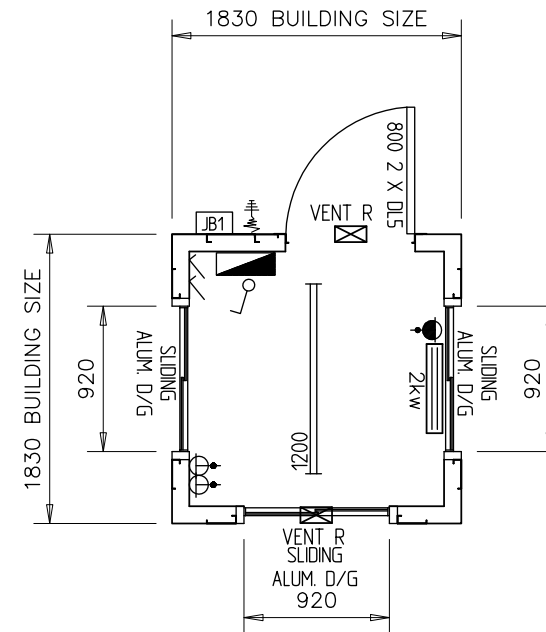


45377

NOTES

- THIS SITE PLAN DRAWING IS INTENDED TO PROVIDE A GENERAL SUMMARY OF THE PROJECT.
- THE INDICATED POSITIONS OF THE UNITS AND ANCILLARY ITEMS ARE FOR ILLUSTRATIVE PURPOSES ONLY.
- FULL SPECIFICATION AND CONFIGURATION DETAILS ARE PROVIDED ON THE INDIVIDUAL UNIT AND ANCILLARY ITEM DRAWINGS, AS REFERENCED.

USE DIMENSIONS - DO NOT SCALE			
Dimension Units ALL IN MILLIMETRES			
Title GENERAL PROJECT SUMMARY			
Product Code _			
Date 30/10/19	Scale NTS	Drawn By RJT	
A		04/11/19	RMC
REV.		DATE	BY
PROCEEDING TO PROJECT STAGE		DESCRIPTION	
Drawing / Unit No. 015692-SP1			Rev. A

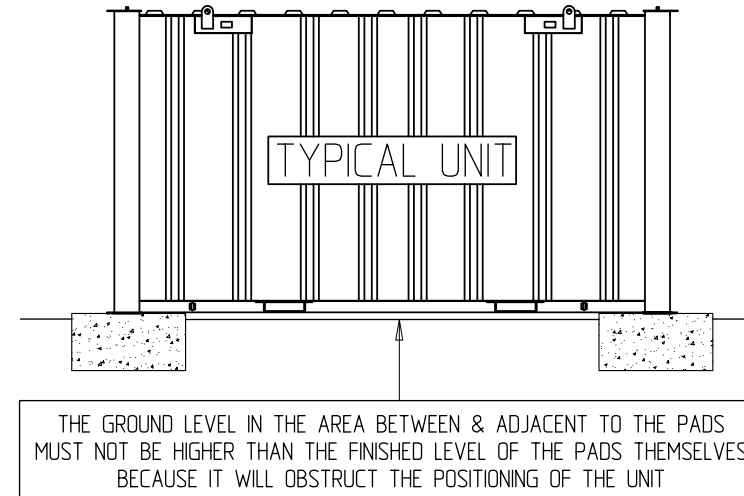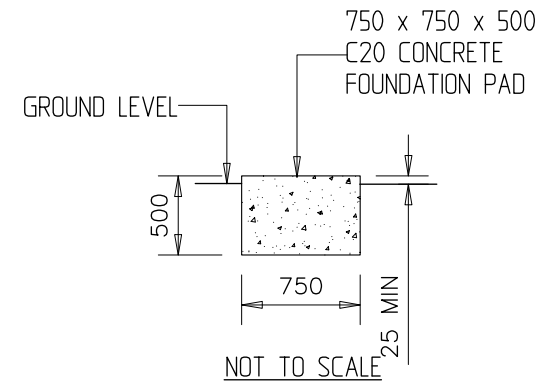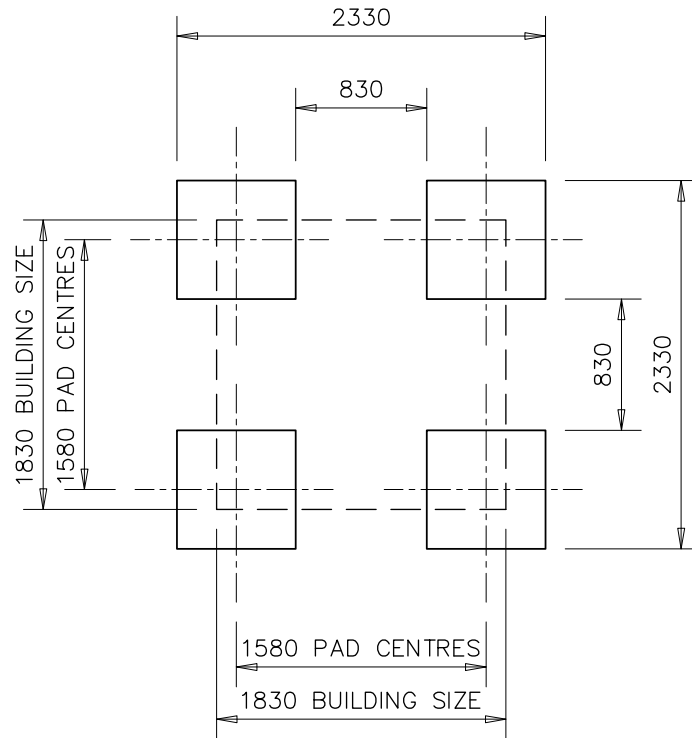

NOTES

1. THIS DESIGN IS SUITABLE ONLY FOR THE SIZE OF UNIT REFERENCED IN THE DRAWING TITLE IN A 1 STOREY CONFIGURATION.
2. ALTERNATIVE DESIGNS ARE AVAILABLE FOR 2 AND 3 STOREY CONFIGURATIONS AND OTHER PRODUCT SIZES.
3. FOUNDATION DESIGN IS FOR A LEVEL SITE WITH A GROUND BEARING CAPACITY OF 110 KN/M SQ. AND A BUILDING FLOOR LOADING OF 3 KN/M SQ.
4. DEPTH OF FOUNDATIONS IS DEPENDENT ON LEVEL OF GROUND BEARING STRATA ON SITE OR AS REQUIRED BY LOCAL AUTHORITY.
A MINIMUM DEPTH OF 500mm IS REQUIRED TO JUSTIFY THE LOAD PRESSURE.

USE DIMENSIONS - DO NOT SCALE		
Dimension Units ALL IN MILLIMETRES		
Title FOUNDATION LAYOUT 6' X 6' - TYPE 1 1 STOREY CONFIGURATION		
Date 04/11/19	Scale 1 : 50	Drawn By RMC
Drawing / Unit No. 015692-F1		Rev. -